



Assinippi Office Park 150 Longwater Drive, Suite 101 Norwell, MA 02061 P: 781.792.3900 F: 781.792.0333

ROAD LIGHTHOUSE 16

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MARSHFIELD, MASSACHUSETTS


CAROLYN CIRCLE

AL RTLS - -

DECEMBER 28, 2023 1"=20" 223-130

EXISTING CONDITIONS PLAN

EX-1

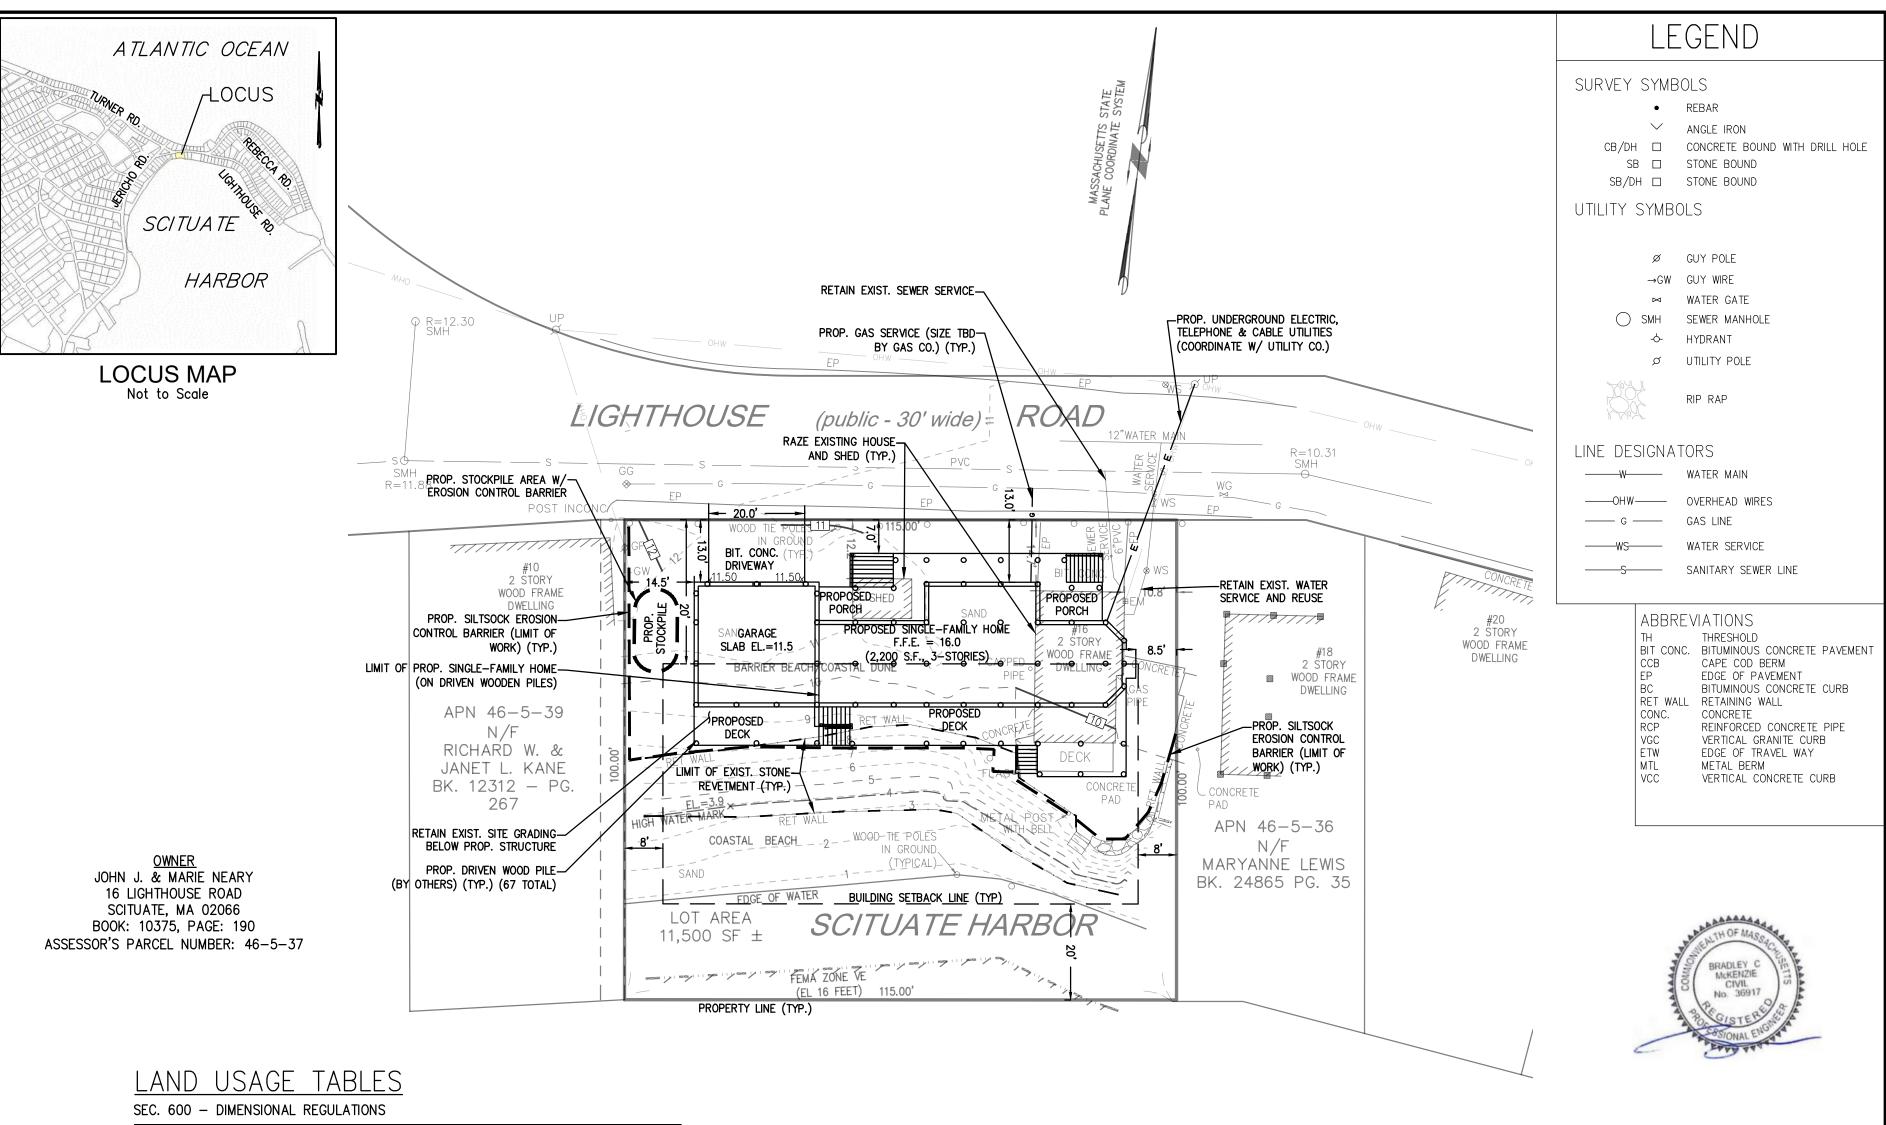

RESIDE	INCE R-3 Z	ZONING DIS	TRICT
CRITERIA	REQUIRED	EXISTING	PROPOSED
LOT AREA (UPLAND)	10,000 S.F.	8,960 S.F.	NO CHANGE
FRONTAGE	100 FT.	115 FT.	NO CHANGE
FRONT YARD	12.1 FT.**	12.2 FT.	13.0 FT.
SIDE YARD (MIN.)	8 FT.	10.8 FT.	8.5 FT.
REAR YARD (MIN.)	20 FT.	47.5 FT.	46.5 FT.
LOT WIDTH	100 FT.	115 FT.	NO CHANGE
BUILDING HEIGHT	3 STORIES 35 FT.	2 STORIES	34.8 FT.

** SEC. 620.4.A. - IN ALL DISTRICTS, NO BUILDING NEED BE SET BACK ON ITS LOT FURTHER FROM THE LINE OF A STREET OR WAY THAN THE AVERAGE DISTANCE FROM SUCH LINE OF THE BUILDINGS ON THE SAME SIDE THEREOF BETWEEN TWO INTERSECTING STREETS AND WAYS AND WITHIN TWO HUNDRED FEET OF THE LOT IN QUESTION. IN DETERMINING SUCH AVERAGE, ACCESSORY BUILDINGS SHALL NOT BE COUNTED. A VACANT LOT OR A LOT OCCUPIED BY A BUILDING SET BACK MORE THAN THE REQUIRED DISTANCE SET FORTH IN THE PRECEDING PARAGRAPH SHALL BE CONSIDERED AS THOUGH OCCUPIED BY A BUILDING SET BACK THE REQUIRED DISTANCE.

SILTSOCK EROSION CONTROL DETAIL

NOT TO SCALE -12" DIAM. BIODEGRADABLE SILT SOCK FILLED WITH 1"x1" STAKES WOOD CHIP COMPOST BLEND EVERY 8 LF 12" DIAM. BIODEGRADABLE DISTURBED SILT SOCK FILLED WITH AREA WOOD CHIP COMPOST BLEND PROTECTED RESOURCE TRAPPED SEDIMENT AREA 1"x1" STAKES DISTURBED CONSISTENT AREA EVERY 8 LF GROUND CONTACT **PROTECTED** RESOURCE AREA

CONSTRUCTION NOTES: 1. SILT SOCKS SHALL BE PLACED IN A ROW WITH ENDS TIGHTLY ABUTTING OR LAPPING THE ADJACENT SECTIONS. 2. SILT SOCKS SHALL BE SECURELY ANCHORED IN PLACE BY STAKES OR RE-BARS DRIVEN EVERY 8 LF.

3. INSPECTION SHALL BE FREQUENT, AND REPAIR OR REPLACEMENT SHALL BE MADE PROMPTLY AS REQUIRED. 4. SILT SOCKS SHALL BE REMOVED WHEN THEY HAVE SERVED THEIR USEFULNESS, SO AS NOT TO BLOCK OR IMPEDE STORM FLOW OR DRAINAGE.

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SECTION

REV DATE		DESCRIPTION	B√	ВҮ АРР
1 2/12/24	2/12/24	WOOD PILES	ESS	ESS BCM



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F: 781.792.0333 www.mckeng.com

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LIGHTHOUSE

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52 CAROLYN CIRCLE MARSHFIELD, MASSACHUSETTS **HOMA** CITUATE S


DRAWN BY: ESS ESS DESIGNED BY: CHECKED BY: BCM APPROVED BY: BCM DECEMBER 28, 2023 DATE: SCALE: 1"=20' PROJECT NO .: 223-130


DWG. TITLE: **PROPOSED**


SITE PLAN


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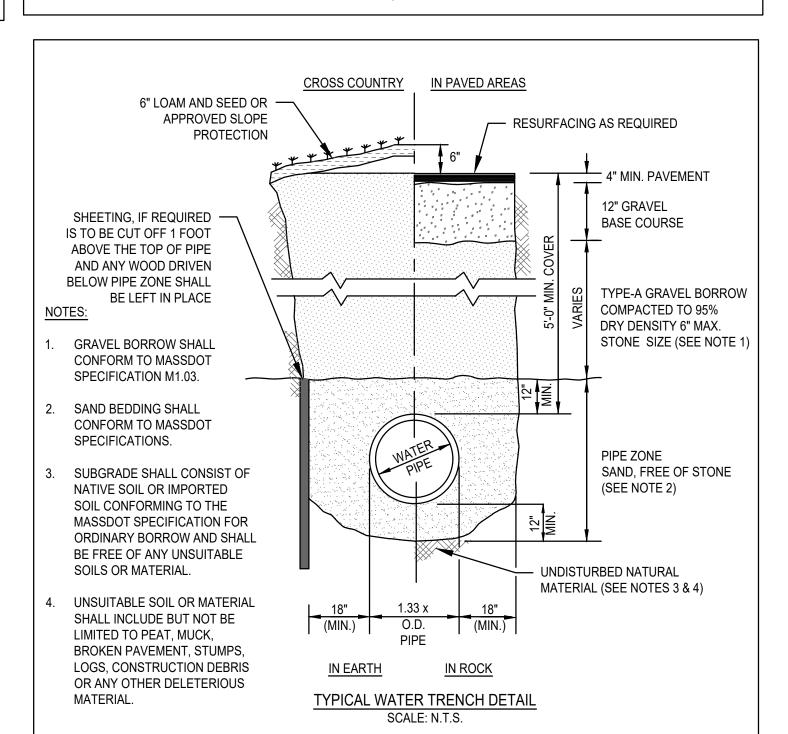
PSP-1




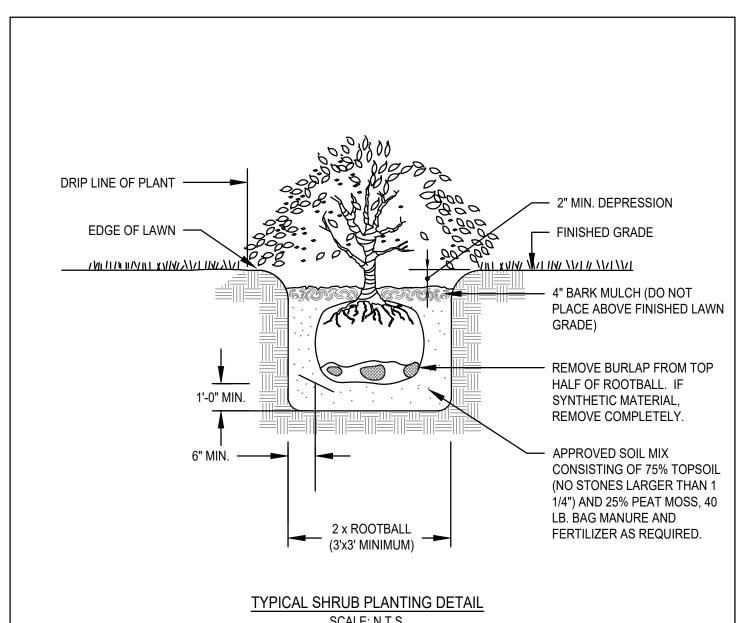

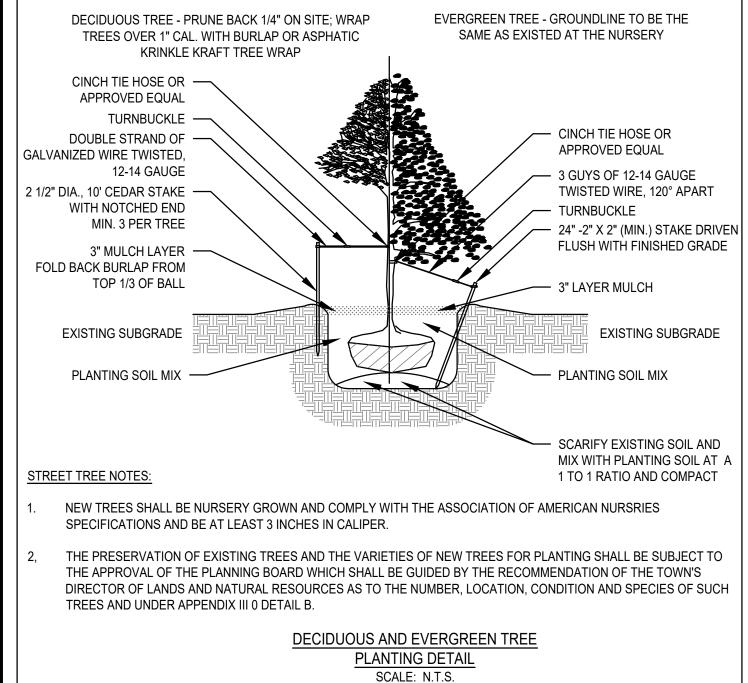

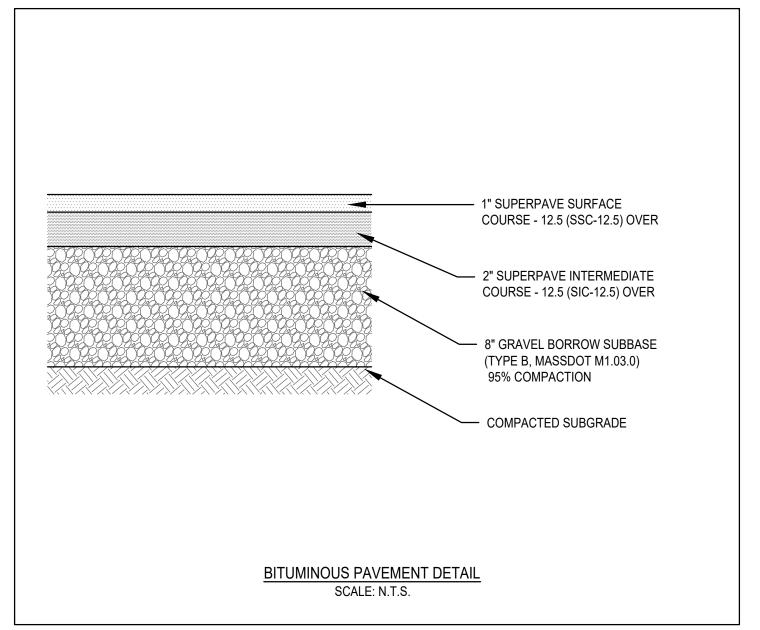

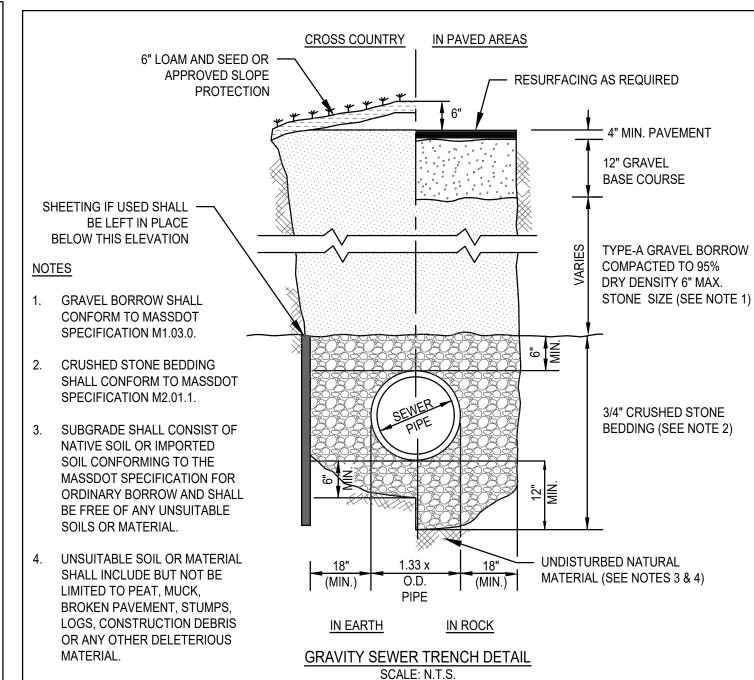

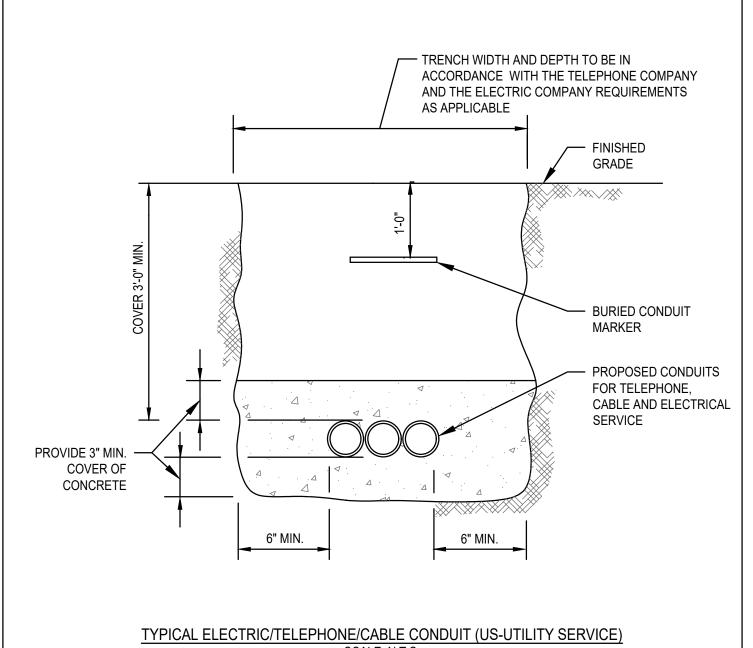

SEEDING SPECIFICATIONS

SEEDING RECOMMENDATIONS

. <u>SEEDBED PREPARATION</u>

2. ESTABLISHING A STAND

NITROGEN (N)

POTASH (K O):

RATES OF SEEDING.

DENSE WEED GROWTH.

NOTES:

1 1/4 INCH

No.4


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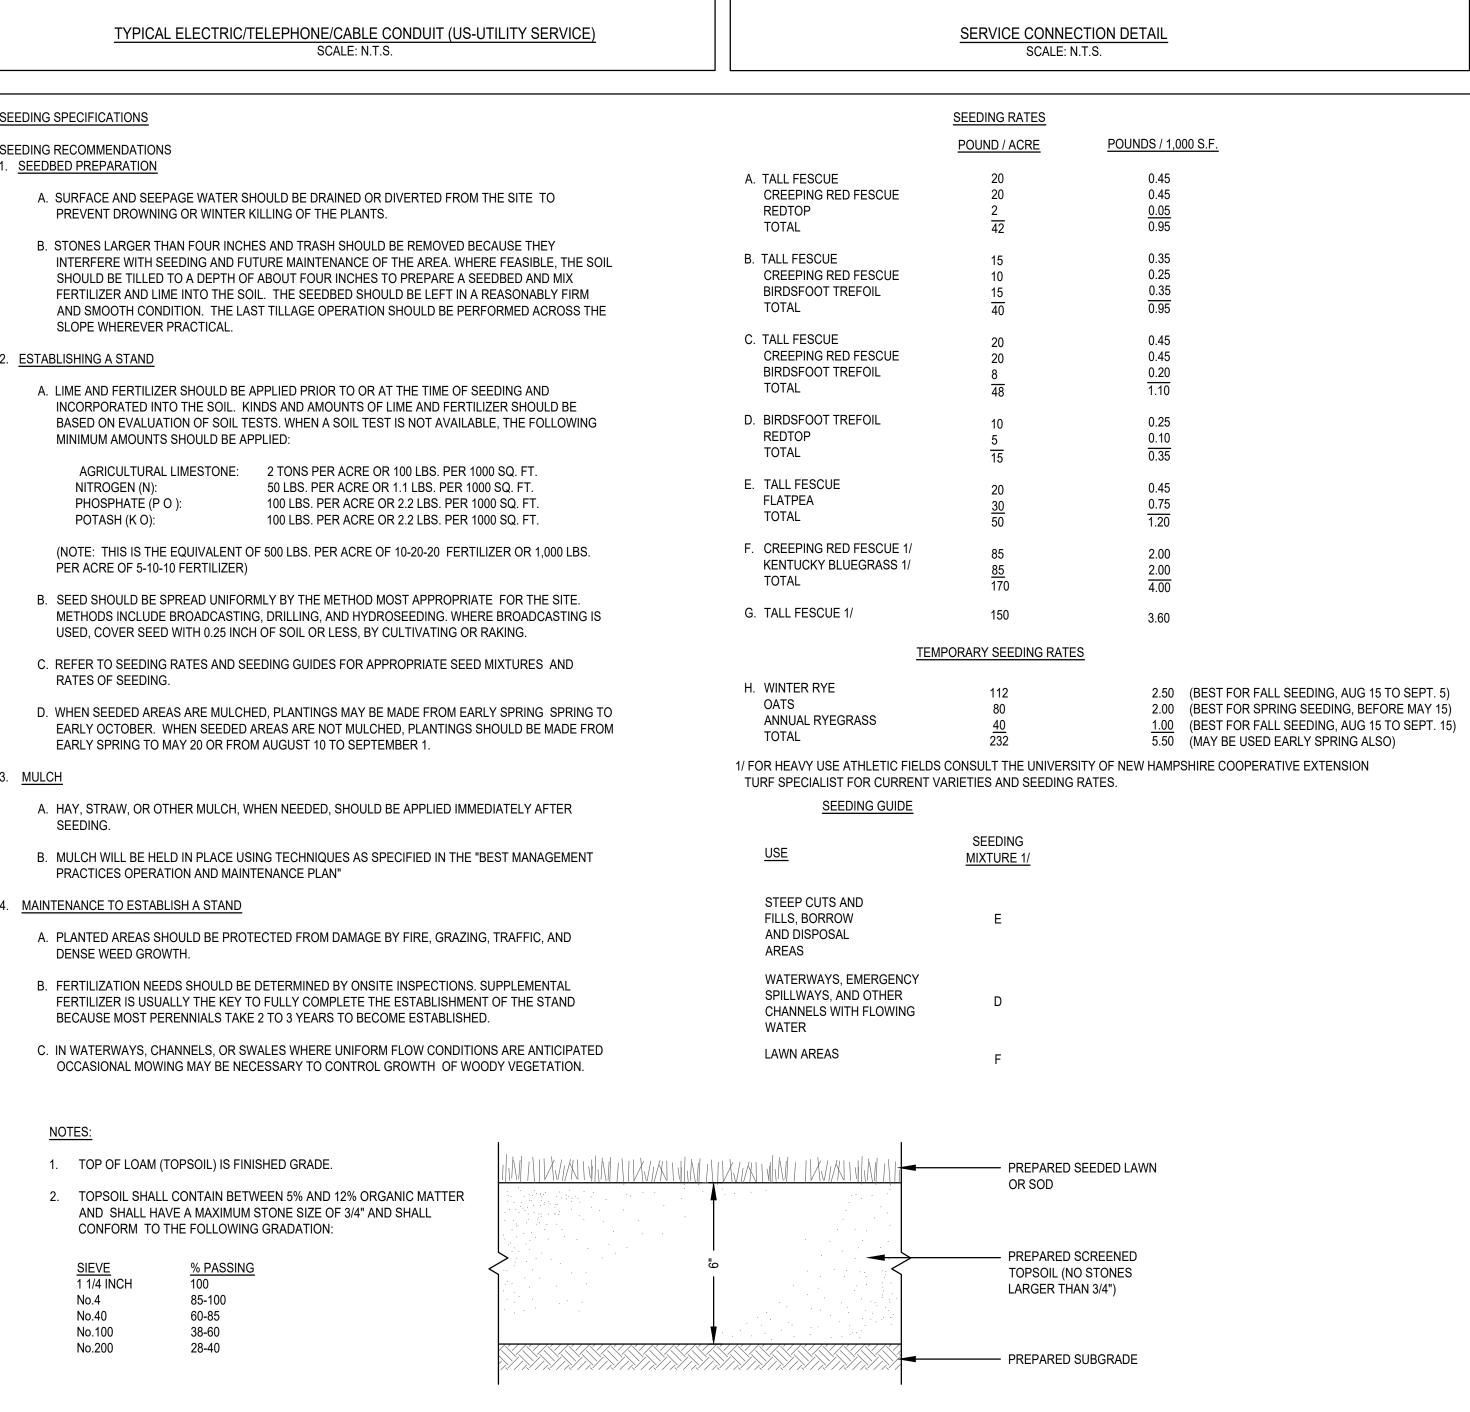
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No.200

3. MULCH


PHOSPHATE (P O):



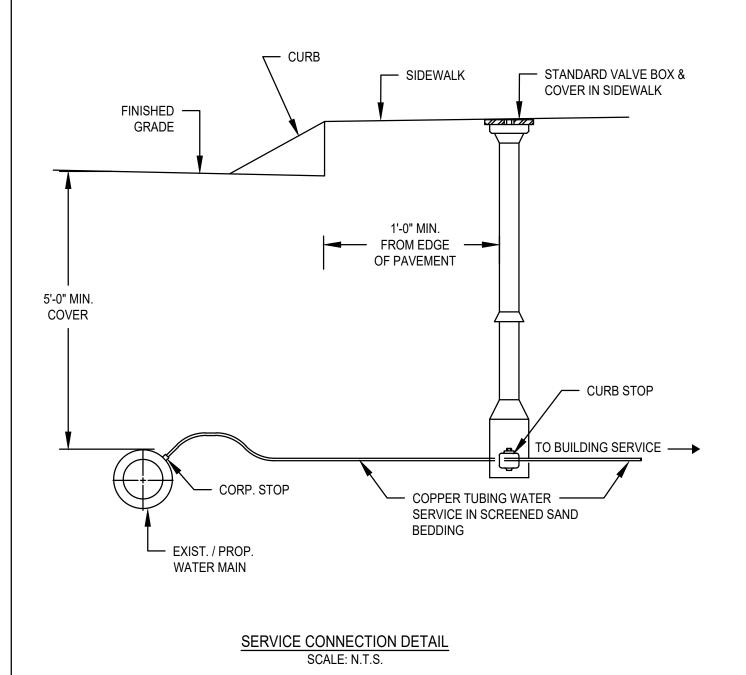

SEEDED OR SODDED LAWN DETAIL

SCALE: N.T.S.

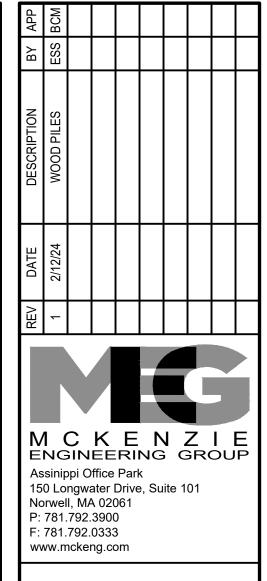

HOU:

PROFESSIONAL ENGINEER:

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OMAS AROLYN C

DRAWN BY: DESIGNED BY: ESS BCM CHECKED BY: APPROVED BY: BCM **DECEMBER 28, 2023** DATE: SCALE: AS NOTED PROJECT NO.: 223-130 DWG. TITLE:

CONSTRUCTION **DETAILS**

DWG. NO: